LDING CODE ANALYSIS E AND OCCUPANCY CLASSIFICATIONS - CHAPTER 3	IBC - 2012 ORDINÁNCE REQUIREMENTS	IBC CODE SECTION	MEANS OF EGRESS - CHAPTER 10 REQUIREMENTS		
QUIREMENTS  I. SECTION 301-303, 309-311: USE AND OCCUPANCY CLASSIFICATION	RESIDENTIAL - GROUP R-2	3Ø2.1	I. SECTION 1003: GENERAL MEANS OF EGRESS  A. GENERAL REQUIREMENTS		
	MERCANTILE - GROUP M ASSEMBLY - GROUP A-2 PARKING - GROUP S-2		A.   GENERAL REQUIREMENTS  I. CEILING HEIGHT  2. HEADROOM  3. HORIZONTAL PROJECTIONS	NOT LESS THAN T'-6" (T'-6" IN GARAGES AND BATHROOMS)  80" OR 6'-8" (STAIRS)  NOT MORE THAN 4"	10
A. INCIDENTAL USE: SEPARATIONS  I. STORAGE ROOMS OVER 100 SF	I HR OR PROVIDE AUTOMATIC FIRE EXTINGUISHER SYSTEM	TABLE 509	EXCEPTIONS: HANDRAILS SERVING STAIRS AND RAMPS 4. FLOOR SURFACE	PERMITTED 4.5" FROM WALL SLIP-RESISTANT SURFACE	10
2. PARKING GARAGE 3. ROOMS WITH ANY BOILER OF 15 PSI & 10 H.P.	2 HR OR I HR W/ 6PRINKLERS  1 HR OR PROVIDE AUTOMATIC FIRE EXTINGUISHER SYSTEM	TABLE 406.4.6 TABLE 509	5. ELEVATION CHANGE  EXCEPTIONS: SINGLE STEP @ 1" MAXIMUM	LESS THAN 12" (GREATER PER RAMP REQUIREMENTS)	16
4. ROOMS CONTAINING FIRE PUMPS IN HIGH-RISE BUIDLINGS B. OCCUPANCY SEPARATIONS: (SEPARATED USES PER IBC 302.1 & 508.4)	2 HR	TABLE 913.2.1	B. OCCUPANT LOAD  1. MAXIMUM ALLOWABLE FLOOR AREA	RESIDENTIAL: 200 GROSS FLOOR AREA PER OCCUPANT	TABLE 10
R2 RESIDENTIAL TO 52 GARAGE R2 RESIDENTIAL TO R2 RESIDENTIAL	2 HRS OR I HR WITH AUTO FIRE EXTINGUISHER SYSTEM, PER TABLE 302.1.1 I HR	TABLE 508.4 108	a.   CALCULATIONS PER FLOOR 2.   OCCUPANT LOAD	SEE OCCUPANCY / TRAVEL DISTANCE CALCULATION SHEET	
R2 RESIDENTIAL TO A2 ASSEMBLY R2 RESIDENTIAL TO M MERCANTILE	2 HRS OR I HR WITH AUTO FIRE EXTINGUISHER SYSTEM, PER TABLE 302.1.1 2 HRS OR I HR WITH AUTO FIRE EXTINGUISHER SYSTEM, PER TABLE 302.1.1	TABLE 508.4 TABLE 508.4	a. PARKING GARAGES b. ACCESSORY STORAGE / MECHANICAL	200 SF/ PERSON GROSS 300 SF/ PERSON GROSS	
A2 ASSEMBLY TO S2 GARAGE	2 HRS OR I HR WITH AUTO FIRE EXTINGUISHER SYSTEM, PER TABLE 302.1.1	TABLE 5 <i>0</i> 8.4	c. OUTDOOR TERRACES / ASSEMBLY UNCONCENTRATED d. FITNESS CENTER (EXERCISE ROOMS)	15 SF/ PERSON NET 50 SF/ PERSON GROSS	
CIAL DETAILED REQUIRMENTS BASED ON USE AND OCCUPANCY - CHAPTER 4  WIREMENTS			e. RESIDENTIAL f. MERCANTILE	200 SF/ PERSON GROSS 30 SF/ PERSON GROSS (SALES FLOOR), 300 SF/ PERSON (STORAGE)	
I. SECTION 403: HIGH RISE BUILDINGS  A. REDUCTION IN FIRE-RESISTANCE RATING	TYPE IA FOR DILL DINGS I FOS THAN 199 FT DATINGS MAY DE DEDUCED	4Ø3.2	g. POOLS  C. EGRESS WIDTH	50 SF/ PERSON GROSS (POOL), 15 SF/ PERSON GROSS (POOL DECK)	
1. TYPE OF CONSTRUCTION	TYPE IA FOR BUILDINGS LESS THAN 420 FT, RATINGS MAY BE REDUCED TO THOSE REQUIRED IIN TYPE IB CONSTRUCTION (EXCEPT COLUMNS)	4@3.2.1.1	1. MINIMUM WITH SPRINKLERS  a. STAIRWAYS: FACTOR Ø3Ø	SEE OCCUPANCY / TRAVEL DISTANCE CALCULATION SHEET	TABLE
2. SHAFT ENCLOSURE	2HR PROVIDED OR I HR WHERE SPRINKLERS ARE ARE WITHIN THE SHAFT AT THE TOP AND AT ALTERNATE FLOOR LEVELS	4Ø3.2.l.2	b. OTHER EGRESS: FACTOR 020  2. ILLUMINATION REQUIREMENTS	SEE OCCUPANCY / TRAVEL DISTANCE CALCULATION SHEET NOT REQUIRED FOR R2 DWELLING UNITS	TABLE
SPRAYED FIRE-RESISTANT MATERIALS (SFRM)      AUTOMATIC SPRINKLER SYSTEM      WATER SUPPLY TO REQUIRE FIRE DIMPO	SFRM MIN. BOND STRENGTH OF 430 PSF  CONTAINS SPRINKLER SYSTEM IN ACCORDANCE WITH SECTION 903.3.1.1	4 <i>0</i> 3.2.4 4 <i>0</i> 3.2.4 4 <i>0</i> 3.3.2	D. ACCESSIBLE MEANS OF EGRESS  I. REQUIREMENTS	MUST COMPLY FOR NEW BUILDINGS  ELEVATOR COMPLYING W/ SECTION 1007.4 NOT REQ'D W/ SPRINKLERS	16
5. WATER SUPPLY TO REQUIRED FIRE PUMPS  6. EMERGENCY SYSTEMS	FIRE PUMP SUPPLIED BY TWO WATER MAIN CONNECTIONS (TWO CONNECTIONS TO ONE MAIN ARE PERMITTED IF MAIN IS VALVED)	405.5.2	2. BUILDINGS WITH 4 OR MORE STORIES 3. ENCLOSED EXIT STAIRWAYS	INSIDE STAIRWELL OR REMOTE ENCLOSED ROOM	is .
a. SMOKE DETECTION	AREA SMOKE DETECTION AND DUCT SMOKE DETECTION PROVIDED  SMOKE DETECTION, FIRE DEPARTMENT COMMUNICATION PROVIDED	403.4.1 907.2.13	a. AREA OF REFUGE b. EXCEPTIONS	4'-0" CLEAR BETWEEN HANDRAILS NOT REQUIRED W/ SPRINKLERS	10
b.   FIRE ALARM SYSTEM  c.   EMERGENCY VOICE/ALARM COMMUNICATION SYSTEM	SYSTEM, AND EMERGENCY VOICE/ALARM COMMUNICATION SYSTEM  PAGING ZONES AT ELEVATORS, EXITS STAIRS, AND A.O.R. PROVIDED	907.5.2.2	4.   AREAS OF REFUGE  a.   MAXIMUM TRAVEL DISTANCE	NOT MORE THAN PERMITTED PER OCCUPANCY ENCLOSED STAIRWAY OR THROUGH CORRIDOR	1
d. EMERGENCY RESPONDER RADIO COVERAGE	PROVIDED IN ACCORDANCE WITH SECTION 510 OF THE IFC	IFC 510	b. ACCESS c. SIZE	30" X 48" SPACE PER 200 OCCUPANTS	10
e.   FIRE COMMAND  i. LOCATION AND ACCESS  ii. SEPARATION	APPROVAL BY FIRE CHIEF  I HR MIN, FIRE BARRIER	911.1.1 911.1.2	d. SEPARATION e. TWO-WAY COMMUNICATION f. IDENTIFICATION	SMOKE BARRIER OR SPRINKLERS  TO CENTRAL CONTROL POINT  DOORWAY SIGNAGE WITH ILLUMINATION	10
II. SEPARATION  III. SIZE  IV. LAYOUT APPROVAL	MIN. 200 SF WITH A MIN DIMENSION OF 10'  APPROVAL OF LAYOUT IS REQUIRED BEFORE INSTALLATION	911.1.2 911.1.3 911.1.4	E. DOORS  I. DOORS: SIZE	32" MINIMUM / 48" MAXIMUM (80" MIN. HEIGHT)	
V. REQUIRED FEATURES	EMERGENCY VOICE/ ALARM COMMUNICATION SYSTEM CONTROL UNIT FIRE DEPT. COMMUNICATION SYSTEM, FIRE DETECTION AND	911.1.5	EXCEPTIONS: GROUP R2  a. DOORS IN DWELLING UNITS	MINIMUM & MAXIMUM NOT APPLY TO INTERIOR UNITS DOORS  NOT LESS THAN 18" IN HEIGHT	
	ALARM ANNUNCIATOR, ANNUNCIATOR ELEVATOR OPERATION INDICATOR, STATUS INDICATORS AND CONTROLS FOR AIR DISTRIBUTION,		b. INTERIOR EGRESS DOORS IN DWELLING UNITS  2. PROJECTIONS:	NOT REQUIRED TO BE ACCESSIBLE  4" MAXIMUM	10
	FIRE-FIGHTER CONTROL PANEL, STAIRWAY DOOR CONTROLS, SPRINKLER VALVE AND WATER FLOW PANELS, EMERGENCY AND STANDBY POWER		3. DOOR SWING OPENING FORCE	IN THE DIRECTION OF EGRESS TRAVEL (IF MORE THAN 50 OCCUPANTS)  5 LBS	14
	STATUS INDICATORS, FIRE DEPT. TELEPHONE, FIRE PUMP STATUS, SCHEMATIC BUILDING PLANS WITH APPLICABLE FIRE DETAILING,		4. FLOOR ELEVATION  a. EXCEPTIONS: DOOR SERVING R2	LEVEL ON EITHER SIDE OF DOOR  PERMITTED SWING OVER LANDING @ TOP STEP OF STAIRS	16
	WORK TABLE, GENERATOR CONTROLS, PUBLIC ADDRESS SYSTEM, ELEVATOR RECALL SWITCH, ELEVATOR EMERGENCY OR STANDBY		b. EXCEPTIONS: INTERIOR FLOOR FINISH  5. THRESHOLDS:	NOT MORE THAN 1/2" IN HEIGHT  NOT TO EXCEED 3/4" HIGH (DWELLING UNITS), 1/2" HIGH (OTHER DOORS)	16
e.   SMOKE REMOVAL	POWER SELECTOR SWITCH  NATURAL AND MECHANICAL VENTILATION PROVIDED	4Ø3.4.7	6. HARDWARE HEIGHT 1. STAIRWAY DOORS	34" MINIMUM & 48" MAXIMUM  UNLOCKED FROM BOTH SIDES, OR LOCKABLE OPPOSITE THE PATH OF	1008.1.9.11, 4
1. STANDBY POWER  a. SPECIAL REQUIREMENTS FOR STANDBY POWER	2 HR FIRE BARRIER PROVIDED FOR GENERATOR ROOM	403.4.8.1	F. STAIRWAYS AND HANDRAILS	EGRESS AND TIED TO FIRE COMMAND CENTER TO FAIL SAFE	,
b. STANDBY POWER LOADS  8. EMERGENCY POWER SYSTEMS	POWER AND LIGHTING, VENT. AND FIRE DETECTION, ELEVATORS	403.4.8.2	1. STAIRWAY WIDTH 2. HEADROOM	NOT LESS THAN 44" OR 3'-8" (36" MIN. W/IN DWELLING UNIT) NOT LESS THAN 80"	1:
a. EMERGENCY POWER LOADS	EXIT SIGNS, AND MEANS OF EGRESS ILLUMINATION, ELEVATOR CAR LIGHTING, EMERGENCY VOICE/ALARM COMMUNICATIONS SYSTEM,	403.4.9.1	3. STAIR TREADS AND RISERS	RISERS 1" MAXIMUM / 4" MINIMUM TREADS II" MINIMUM	10
	AUTOMATIC FIRE DETECTION 9Y9TEM9, FIRE ALARM 9Y9TEM, ELECTRICALLY POWERED FIRE PUMP		4. STAIRWAY LANDINGS 5. VERTICAL RISE	NOT LESS THAN STAIRWAY WIDTH NOT MORE THAN 12'-0" RISE	10
9.   MEANS OF EGRESS  a.   REMOTENESS OF EXIT STAIR ENCLOSURE	NOT LESS THAN 30' OR NOT LESS THAN 1/4 OF THE LENGTH OF THE	403.5.1	6. HANDRAILS a. HEIGHT	EACH SIDE OF STAIRS BETWEEN 34" - 38"	16
	OF THE MAX OVERALL DIAGONAL DIMENSION OF THE BUILDING OR AREA TO BE SERVED, WHICHEVER IS LESS		b. INTERMEDIATE HAND RAILS c. HANDRAIL GRASPABILITY	STAIRWAY WIDTH WITHIN 30"  MIN. 1 1/4" OUTSIDE DIAMETER (NOT MORE THAN 2")	
b. SMOKE PROOF EXIT ENCLOSURES	REQUIRED FOR STAIRWAYS SERVING FLOOR MORE THAN 15' HIGHEST POINT OF FIRE DEPT VEHICLE ACCESS	403.5.4	d. EXTENSIONS e. CLEARANCE	12" @ TOP TREAD WIDTH,   12" + TREAD @ BOTTOM	
c. LUMINOUS EGRESS PATH d. EMERGENCY ESCAPE AND RESCUE	REQUIRED IN ACCORDANCE WITH SECTION 1024  EMERGENCY ESCAPE AND RESCUE OPENINGS REQUIRED BY	403.5.5 403.5.6	f. STAIRWELL TO ROOF: 4 OR MORE STORIES G. RAMPS	REQUIRED: ONE STAIRWAY ACCESS	16
10. ELEVATORS	SECTION 1029 ARE NOT REQUIRED		SLOPE  2. VERTICAL RISE	1:12 SLOPE (MAX @ 8%) MAXIMUM 30" OR 2'-6"	
a.   FIRE SERVICE ACCESS ELEVATOR	REQUIRED FOR BUILDINGS OVER 120' (N/A FOR THIS PROJECT)	403.6.1	3. WIDTH 4. LANDINGS	36" MINIMUM WIDTH X 60" (ONE DIRECTION)	10
ERAL BUILDING HEIGHTS AND AREAS - CHAPTER 5  UIREMENTS			5. HANDRAILS	60" X 60" (CHANGE IN DIRECTION) REQUIRED EACH SIDE FOR RISE MORE THAN 6"	
I. SECTION 503  A. RESIDENTIAL GROUP R2 (PRIMARY OCCUPANCY)	TYPE IB - II STORIES MAX. HEIGHT, UNLIMITED AREA)	TABLE 503	II. SECTION 1015: EXIT & EXIT ACCESS DOORWAYS		
ASSEMBLY GROUP A-2 MERCANTILE GROUP M PARKING GARAGE GROUP 5-2	TYPE IB - 11 STORIES MAX. HEIGHT, UNLIMITED AREA)  TYPE IB - 11 STORIES MAX. HEIGHT, UNLIMITED AREA)  TYPE IB - 11 STORIES MAX. HEIGHT, 19,000SF MAX. AREA/ FLOOR)		A. EXIT AND EXIT ACCESS DOORWAYS  1. REQUIREMENTS  2. OCCUPANT LOAD	TWO EXITS REQUIRED (MINIMUM)  GROUP R - MAXIMUM OF 10 PERSONS FOR ONE EXIT ONLY	TABLE
E OF CONSTRUCTION - CHAPTER 6	THE ID - II STORIES HAY, HEIGHT, TJOSEST HAY, AREA TEOORY		3. DOORWAY ARRANGEMENTS: REMOTENESS  a. WITH SPRINKLERS	NOT LESS THAN 1/2 REQUIRED DIAGONAL DISTANCE OF ROOM  NOT LESS THAN 1/3 REQUIRED DIAGONAL DISTANCE OF ROOM	TADLL
I. SECTION 602: CONSTRUCTION CLASSIFICATION			4. BOILERS, INCINERATORS, AND FURNACE ROOMS OVER 500 SF	TWO EXIT ACCESS DOORWAYS	
A. TYPE IB  II. SECTION 603: COMBUSTIBLE MATERIALS IN TYPE IA \$ 2A	NON-COMBUSTIBLE MATERIALS	602.2	A. LIMITATIONS  B. TRAVEL DISTANCE: OCCUPANCY GROUP R	PER TABLE: A-2, M, R-2 = 250', S-2 = 400' 250'-0" WITH SPRINKLERS (200'-0" WITHOUT)	TABLE
A. FIRE RETARDANT TREATED WOOD PERMITTED	NON BEARING PARTITIONS AND EXTERIOR WALLS, NON BEARING ROOF EXTERIOR WALLS WHERE NO FIRE RATING IS REQUIRED. ROOF CONST.		IV. SECTION IØIS: CORRIDORS  A. CORRIDOR FIRE RESISTANCE RATING	1/2 HR W/ \$PRINKLER\$ (R-2) Ø HR W/ \$PRINKLER\$ (A-2, M, \$-2)	TABLE
B. INTERIOR FLOOR FINISH, TRIM AND MILLWORK C. INSTALLED LESS THAN 15'-Ø" ABOVE GRADE: WINDOWS, NAILING, OR	PERMITTED PERMITTED		B. CORRIDOR WIDTH  I. EXCEPTION	NOT LESS THAN 44" 36" WITHIN DWELLING UNIT	
FURRING STRIPS  III. TABLE 601: FIRE RESISTANCE RATING FOR BUILDING ELEMENTS		6ØI	C. DEAD ENDS  I. EXCEPTION	NOT MORE THAN 20'-0"  WITH AUTOMATIC SPRINKLER 50'-0" MAXIMIUM	1,
A. STRUCTURAL FRAME (COLUMNS, GIRDERS AND TRUSSES) B. BEARING WALLS (EXTERIOR)	2 HR 2 HR		D. AIR MOVEMENT IN CORRIDORS  Y. SECTION 1019: NUMBER OF EXITS & CONTINUITY	CORRIDOR SHALL NOT SERVE AS A VENTILATION AIR DUCT	
BEARING WALLS (INTERIOR) C. NON BEARING WALLS AND PARTITIONS	2 HR PER TABLE 602 - 0HR FOR INT. / IHR FOR EXT.		A. NUMBER OF EXITS AND CONTINUITY I. MINIMUM: OCCUPANT LOAD	1 - 500 (2 EXITS MINIMUM)	TABLE
D. FLOOR CONSTRUCTION AND SECONDARY MEMBERS E. ROOF: INCLUDING SUPPORTING BEAMS AND JOISTS	2 HR 1 HR		IV. SECTION 1022: VERTICAL EXIT ENCLOSURES  A. ENCLOSURES REQUIRED	2-HR RATING WHERE STAIRS CONNECT 4 OR MORE STORIES	
V. TABLE 602: FIRE SEPARATION DISTANCE FOR EXTERIOR WALLS A. TYPE IB CONSTRUCTION			B. ENCLOSURES UNDER STAIRWAYS C. UNIT STAIRWAYS	I-HR RATING REQUIRED  NOT REQ'D TO BE ENCLOSED	
INTERIOR / EXTERIOR FIRE SEPARATION     LESS THAN 5FT:	I HR RATING (GROUP A-2, R-2, 6-2), 2HR RATING (GROUP M)		D. SMOKEPROOF ENCLOSURES	STORIES OVER 15 FT. ABOVE THE LOWEST LEVEL, SMOKEPROOF ENCLOSURE OR PRESSURIZED STAIRWAY REQ'D.	1
MORE THAN 5 FT, LESS THAN 10FT:  MORE THAN 10FT, LESS THAN 30FT (1HR RATING)	1 HR RATING (GROUP A-2, R-2, S-2), 2HR RATING (GROUP M) 1 HR RATING (ALL OCCUPANCIES)		I. ENCLOSURE EXIT  V. SECTION 1023: EXIT PASSAGEWAYS	2-HR RATED EXIT PASSAGEWAY FROM STAIRWAY	10
MORE THAN 30FT	NO RATING REQUIRED (ALL OCCUPANCIES)		A. WIDTH	NOT LESS THAN 44", EXCEPT PASSAGEWAYS SERVING OCCUPANT LOAD LESS THAN 50 PERSONS SHALL BE NOT LESS THAN 36"	
RESISTANCE - RATED CONSTRUCTION - CHAPTER 1  JIREMENTS			VI. SECTION 1025: HORIZONTAL EXITS A.	2 HR ENCLOSURE	
I. SECTION 105: EXTERIOR WALLS  A. TYPE IB CONSTRUCTION	PROJECTIONS FROM WALL (NON-COMBUSTIBLE) - N/A PER EXCEPTION	7/05.2	B. OPENING PROTECTIVES C. CAPACITY OF REFUGE AREA	SELF-CLOSING FIRE DOORS 3 SF / OCCUPANT	
B. VERTICAL SEPARATION OF OPENINGS C. PARAPETS	DOES NOT APPLY WITH AUTOMATIC SPRINKLER SYSTEM PROVIDED	705.8.5 705.11.1	VII. SECTION 1029: EMERGENCY ESCAPE AND RESCUE  A. GENERAL	AT I PART ALIP PLATERIAN IN THE STATE OF THE	
II. SECTION 106: FIRE WALLS  A. PER TABLE 106.4	a ume	706.4	1. EMERGENCY ESCAPE AND RESCUE REQUIREMENTS	AT LEAST ONE EXTERIOR EMERGENCY ESCAPE  BASEMENT + SLEEPING ROOMS LESS THAN 4 STORIES  MINIMUM NET CLEAR OPENING OF EACE	
OCCUPANCY GROUP R-2, A-2, M OCCUPANCY GROUP 9-2	3 HR6 2 HR6		2. MINIMUM SIZE 3. MINIMUM DIMENSIONS	MINIMUM NET CLEAR OPENING OF 5.7 SF HEIGHT OF 24", WIDTH OF 20"	1
III.   SECTION 101: FIRE BARRIERS/ SHAFT ENCLOSURES  A.   SHAFTS	2 HRS (CONNECTING 4 + STORIES)	707.3.1/ 713.4	4. MAXIMUM HEIGHT FROM FLOOR 5. OPERATIONAL CONSTRAINTS	44" FROM THE FLOOR TO CLEAR OPENING  WITHOUT KEY OR TOOLS  OPENING SILL BELOW AD LACENT GROUND LEVEL	
B. SHAFT OPENINGS	1 HR (CONNECTING LESS THAN 4 STORIES) PER FIRE BARRIER REQUIREMENTS	707.6	6. WINDOW WELLS  a. MINIMUM SIZE  b. LADDEDS OR STERS WINDOW WELLS DEBT	OPENING SILL BELOW ADJACENT GROUND LEVEL  MINIMUM ACCESSIBLE NET CLEAR AREA OF 9 SF, W = 36"  DEEDMANENT LADDER IIL 12" MINIMUM 3" PRO JECTION	1
C. REFUSE AND LAUNDRY CHUTES  I. OPENINGS  2. ACCESS ROOMS	SELF CLOSING W/ SMOKE DETECTOR	713.13.1 713.13.3	b.   LADDERS OR STEPS; WINDOW WELLS DEPTH  GREATER THAN 44"	PERMANENT LADDER W=12" MINIMUM, 3" PROJECTION	10
2. ACCESS ROOMS 3. TERMINATION ROOM 4. SPRINKLERS	1 HR ENCLOSURE (3/4 HR FOR SELF-CLOSING DOORS)  RATING TO MATCH THE REQUIRED RATING FOR THE SHAFT ENCLOSURE  AUTOMATIC SERVICE SERVICED	713.13.3 713.13.4 713.13.6	ACCESSIBILITY - CHAPTER II REQUIREMENTS		
4.   SPRINCLERS D.   ELEVATOR LOBBY 1.   SEPARATION	AUTOMATIC SPRINKLERS REQUIRED  FIRE-RATED DOORS - REQUIREMENT APPLIES IS SERVING AN	713.14.1.4	I. SECTION 1104: ACCESSIBLE ROUTE  A. SITE ARRIVAL / WITHIN A SITE	ACCESSIBLE ROUTE	
I. SEPARATION  IV. SECTION 108: FIRE PARTITIONS	OCCUPIED FLOOR AT LEAST 15' ABOVE FD ACCESS	11,41,41 11,41,41	B. CONNECTED SPACES  II, SECTION 1106: PARKING AND PASSENGER LOADING FACILITIES	ACCESSIBLE ROUTE  ACCESSIBLE ROUTE	
V. SECTION 108: FIRE PARTITIONS  A. SEPARATION OF SLEEPING UNITS: GROUP R2  B. CORRIDOR WALLS	1 HR DEMISING WALLS	708.3 708.3	II, SECTION 1106: PARKING AND PASSENGER LOADING FACILITIES  A. GROUP R2 - ACCESSIBLE PARKING SPACES  III, SECTION 1107: DWELLING AND SLEEPING UNITS	FOR 501-1000 SPACES: 2% TOTAL SPACES TO BE ACCESSIBLE	TABLE
B. CORRIDOR WALLS C. ELEVATOR LOBBY V. SECTION 109: SMOKE BARRIERS	1/2 HR 1 HR	713.14.1	A. DESIGN	GROUP R  2% OF TOTAL UNITS TO BE TYPE A, ALL OTHER UNITS TO BE TYPE B	1107.6.2.1, 11
V.   SECTION 109: SHOKE BARRIERS  A.   REQUIREMENTS  VI.   SECTION 116: OPENING PROTECTIVES	1 HR	7/09.3	IV. SECTION IIIØ: SIGNAGE  A. SIGNS	AREA OF REFUGE, TOILETS, ENTRANCES, PARKING SPACES	118 J. L. S. C. L. J.
A.   FIRE RATED GLASS: LIMIT AREA  /II.   SECTION 116: DUCTS AND AIR TRANSFER OPENINGS	1-2 HR5 (100 5Q IN)	716.5	A.   SIGNS   ACCESSIBILITY - FHA	THE STATE OF THE SOL, TOTAL TO, LISTINGS OF ACED	
A.   FIRE DAMPERS	NOT REQUIRED AT RATED PENETRATIONS	717.5.4	REQUIREMENTS  I. ACCESSIBLE BUILDING ENTRANCE ON AN ACCESSIBLE ROUTE		CHAPTER
PROTECTION SYSTEMS - CHAPTER 9  UIREMENTS			A. ACCESSIBLE BUILDING ENTRANCE ON AN ACCESSIBLE ROUTE  A. ACCESSIBLE ENTRANCE FROM THE PUBLIC WAY  B. ACCESSIBLE ENTRANCE FROM THE PARKING	ACCESSIBLE ROUTE  ACCESSIBLE ROUTE	CHAFTER
I.   SECTION 903; AUTOMATIC SPRINKLER SYSTEMS  A.   GROUP R2	REQUIRED AUTOMATIC SPRINKLER SYSTEM	9Ø32.8	II. ACCESSIBLE ENTRANCE FROM THE PARKING  II. ACCESSIBLE COMMON AND PUBLIC USE AREA  A. AMMENITY SPACES AND LOBBY	COMMON AREAS ARE ACCESSIBLE	CHAPTER
A. GROUP RZ B. CHUTES C. STANDARDS	SPRINKLER & TOP OF RUBBISH CHUTE  PER NFPA 13	903.2.8 903.2.11.2 903.3.1	A.   AMMENTY SPACES AND LOBBY  III.   USABLE DOORS  A.   DOOR WIDTH 32" MINIMUM	PROVIDED	CHAPTER
D. NFPA 13 R (IF APPLICABLE)  E. ALARMS AND CONTROLS	LESS THAN 4 STORIES IN HEIGHT ALLOWED  AS REQUIRED	903.3.1.2 903.4.2	B. MANUVERABILTY AT DOORS  IV. ACCESSIBLE ROUTE INTO AND THROUGH A DWELLING UNIT	PROVIDED PROVIDED	CHAPTER
	TO INDUINE	JØ 2.4.2	V. LIGHT SUITCHES, ELEC. OUTLETS, THERMOSTATS AND OTHER	PROVIDED	CHAPTER
II.   SECTION 906: PORTABLE FIRE EXTINGUISHERS  A.   PER INTERNATIONAL FIRE CODE	AS REQUIRED - 1/ 11250 SF OR 1/ 15' TRAVEL DISTANCE	906.1	ENVIRONMENTAL CONTROLS IN ACCESSIBLE LOCATIONS		

AREA FOR CITY APPROVAL STAMP

Contractor shall be responsible for reviewing all Plans and Specifications, verifying all existing conditions prior to proceeding with Construction, complying with all applicable building codes, and notifying Architect immediately of any discrepancies or conflicts.
Contractor shall construct the work in conformance with all applicable building codes.

Contractor is responsible for design and installation of properly sized and loaded systems. submit shop drawings to architect for approval on conformity to Architectural design intent.

A written Architectural Specification was issued for this project and along with these printed documents constitute the Contract Documents for this project. Work scope pertinent to all disciplines occurs throughout the Contract Documents. By submitting a bid for this work the Contractor and all subcontractors attest that they have reviewed the entire contract document set and site conditions and have included all applicable work. Additional Architectural Specification copies are available anytime upon request.

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### HERE KANSAS

OWNER: HERE KANSAS 908 N. HALSTED CHICAGO IL 60607 p. 312 642 0170 jwh@here-llc.com

1101 INDIANA ST Lawrence, KS

	DATE	ISSUED FOR
$\triangle$	02/05/14	PDP RESUBMITTAL
$\bigcirc$	05/06/14	PDP RESUBMITTAL
$\bigcirc$	06/11/14	PDP RESUBMITTAL
$\triangle$		
$\wedge$		

HARTSHORNE PLUNKARD ARCHITECTURE



232 NORTH CARPENTER STREET CHICAGO, IL 60607 312.226.4488 HPARCHITECTURE.COM

PROJ. # 1324 SCALE:
CK. BY: JM DN. BY: KF, NS, JP

CODE ANALYSIS



# 1101 INDIANA ST.

LAWRENCE, KS

#### PROJECT NOTES

HERE Kansas, LLC 908 N. Halsted, Chicago, II 60607

PROPERTY DESCRIPTION

p. 312 642 0170 jwh@here-llc.com

OWNER

1. NO BALCONIES ARE PROPOSED ON THIS PROJECT.

4. SWIMMING POOL SHALL COMPLY WITH CITY CODE CHAPTER 19, ARTICLE 11

PROPOSED TO BE DEMOLISHED.

AMERICANS WITH DISABILITIES ACT ACCESSIBILITY GUIDELINES FOR BUILDING,

LOTS 1-6 IN BLOCK 14, LANE'S SECOND ADDITION, AN ADDITION TO THE CITY OF LAWRENCE; AND LOT 1 THE NORTH HALF OF LOT 2, AND ALL OF LOTS 3-5 AND 9-12 IN BLOCK 9, OREAD ADDITION TO THE CITY OF LAWRENCE, ALL IN DOUGLAS COUNTY, KANSAS.

**GENERAL NOTES** 

2. ALL ACCESSIBLE SIDEWALK RAMPS PER ADA STANDARDS. 3. CONTRACTOR TO VERIFY ALL UTILITY LOCATIONS PRIOR TO EXCAVATION.

5. ALL MECHANICAL EQUIPMENT SHALL BE SCREENED FROM THE RIGHT-OF-WAY

6. ALL EXISTING BUILDINGS AND STRUCTURES CURRENTLY ON THE SITE ARE

7. THIS SITE PLAN IS INTENDED TO COMPLY WITH THE PROVISIONS OF THE


PARKING, AND PEDESTRIAN ACCESS.

#### PROJECT DATA

	PROPOSED	NOTES
UNDERLYING ZONE USES	MU (PLANNED DEVELOPMENT) RESIDENTIAL/ RETAIL	
SITE AREA GROSS BUILDING AREA	110,120 SF (2.53 ACRES) 445,300 SF	REFER TO PLANS FOR AREA SUMMARY. (W/O OPEN SPACE, REC OPEN + OUTDOOR AMENITY)

SITE SUMMARY				
	EXISTING / REQUIRED	PROPOSED	CHANGE	NOTES
LAND USE				
	MU PLANNED DEVELOPMENT	MU PLANNED DEVELOPMENT	-	
	RESIDENTIAL	RESIDENTIAL	-	
	PARKING	PARKING	-	
	-	RETAIL	-	
	-	MECH/STORAGE	-	
	-	RESIDENTIAL AMENITY	-	
LAND AREA (SQ FT)		ı		
RESIDENTIAL	40 UNITS/ ACRE	68 UNITS/ ACRE	+ 28 UNITS/ ACRE	1-BD = 0.4 unit; 2-BD = 0.6 unit;
	-	265,604 SF	+ 265,604 SF	3-BD = 0.8 unit; 4+BD = 1 unit
# OF UNITS (ACTUAL)	103 UNITS	237 UNITS	+ 134 UNITS	56 (1 bed) x 0.4 = 22
# OF UNITS (PER ZONING CALCULATION)	95 UNITS	173 UNITS	+ 77 UNITS	$67 (2 \text{ bed}) \times 0.6 = 40$
OFF STREET PARKING PROVIDED	165 SPACES	577 SPACES	+ 412 SPACES	22 (3 bed) x 0.8 = 18
	-	126,038 SF	+ 126,038 SF	$92 (4 \text{ bed}) \times 1.0 = 92$
RETAIL	-	13,137 SF	+ 13,137 SF	
MECH/STORAGE	-	21,109 SF	+ 21,109 SF	REFER TO PDP-02 FOR
RESIDENTIAL AMENITY	-	16,716 SF	+ 16,716 SF	CALCULATION
RESIDENTIAL OFFICE	-	2,696 SF	+ 2,696 SF	
COMMON OPEN SPACE	-	39,121 SF	+ 39,121 SF	SEE SHEET PDP-06 FOR NOTES +
RECREATIONAL OPEN SPACE	-	20,162 SF	+ 20,162 SF	CALCULATIONS
OUTDOOR AREA	50 SF/UNIT	25,257 SF (107 SF/UNIT)	+ 57 SF/UNIT	(LABELED AS OUTDOOR AMENITY
(per sec. 20-601-a)				
TOTAL SITE AREA	112,120 SF	112,120 SF	-	
TOTAL IMPERVIOUS AREA (SQ FT)	69,758 SF	69,758 SF	0	
% IMPERVIOUS	63.3%	63.3%	0	
TOTAL PERVIOUS AREA (SQ FT)	40,362 SF	40,362 SF	0	
% PERVIOUS	36.7%	36.7%	0	

USE	REQUIREMENT	SPACES REQUIRED	SPACES PROVIDED	NOTES
UNIT PARKING	1 / BEDROOM	624	-	
GUEST PARKING	1 / 10 UNITS	18	-	
RETAIL PARKING	1 / 300 SF (ESTIMATE)	34	-	
RESTAURANT PARKING	1 / 45 SF (ESTIMATE)	38	-	
	+ 10 (EMPLOYEES)			
OFF STREET PROVIDED	-		577	
ON STREET PROVIDED	•		107	
DEVELOPMENT BONUS POINTS	-1 SPACE / 5 POINTS	-2		
SHARED PARKING	5% OF PARKING PROVIDED	-28		
TOTAL		684	684	

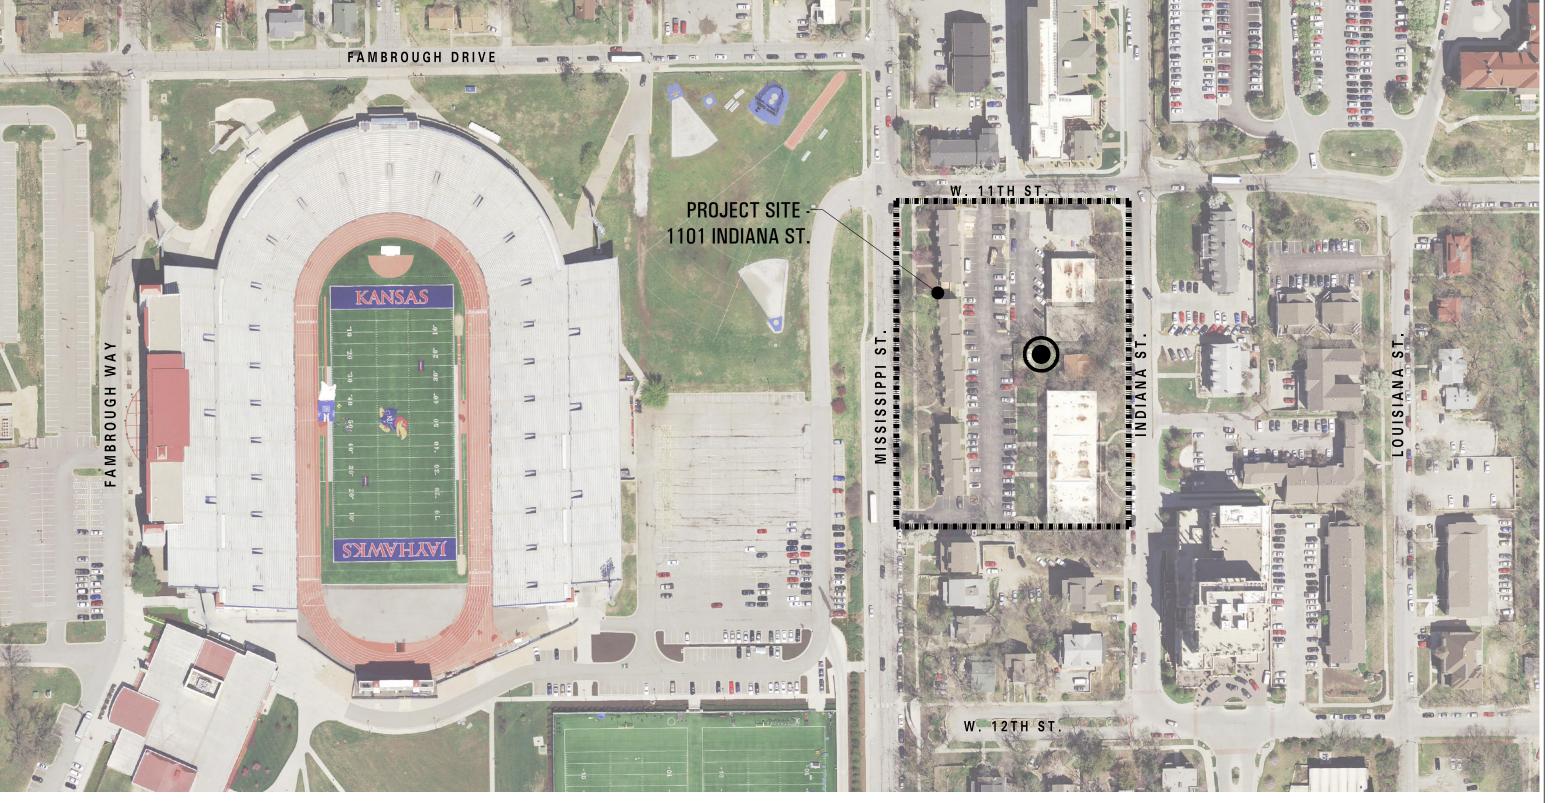

**LOCATION MAP** 

LEGEND						
ELEVATION MARKING	□ ROOM	[XXXXXXX]	BATT. INSUL. OR SOUND ATTN. BLANKET		MORTAR, GROUT,	
REVISION	PARTITION TYPE		BRICK (SECTION)		THINSET OR CEMENT PLASTER	
			BRICK (ELEVATION)	1000	GYPSUM BOARD	
() LARGE SCALE DETAIL	OOR MARK	لىلىلىل	CARPET		METAL LATH & PLASTER	
DETAIL SHEET NUMBER	EXISTING CONSTRUCTION TO REMAIN		CONCRETE		PLYWOOD	
	NEW PARTITION - SEE PLANS FOR TY	PE SSE	CONCRETE BLOCK		QUARRY TILE OR CERAMIC TILE	
SECTION SHEET NUMBER	NEW FARMION - SEE FEARS FOR THE		GLASS (ELEVATION)		RIGID INSULATION	
	EXISTING CONSTRUCTION TO BE REMO	DVED	GLASS (SECTION)		STEEL	
ELEVATION SHEET NUMBER	ACOUSTIC TILE				WOOD FINISH	
	ZZZZ ALUMINUM				WOOD ROUGH OR FRAMING	

BUILDING A	AREA BY FLOO	R									
SHEET	FLOOR	OPEN SPACE	REC. OPEN SPACE	OUTDOOR AMENTIY	RETAIL	PARKING	MECHANICAL	RESIDENTIAL	RESIDENTIAL AMENITY	RESIDENTIAL OFFICE	TOTAL
PDP-01		39,121	20,162								59,283
PDP-04	1ST				5,988	52,165	2,380	2,444			62,977
PDP-05	2ND					73,873		392			74,265
PDP-06	3RD			25,257	4,476		9,703	33,309	12,326	1,327	86,986
PDP-07	4TH						2,384	32,469	4,390	1,369	40,612
PDP-08	5TH				2,673		2,308	55,551			60,532
PDP-09	6TH						2,246	56,225			58,471
PDP-10	7TH						2,088	59,056			61,144
PDP-11	7TH UPPER							26,158			26,158
											529,840
TOTAL		39,121	20,162	25,257	13,137	126,038	21,109	265,604	16,716	2,696	445,300

(W/O OPEN SPACE, REC OPEN + OUTDOOR AMENITY)

SCALE: N.T.S.

AREA FOR CITY APPROVAL STAMP

#### DRAWING LIST

<b>D</b>	
PDP-01	PROJECT DATA & LOCATION PLAN
PDP-01.1	CODE ANALYSIS
PDP-02	SITE PLAN
PDP-03	LANDSCAPE PLAN
PDP-04	FIRST FLOOR
PDP-05	SECOND FLOOR
PDP-06	THIRD FLOOR
PDP-07	FOURTH FLOOR
PDP-08	FIFTH FLOOR
PDP-09	SIXTH FLOOR
PDP-10	SEVENTH FLOOR
PDP-11	SEVENTH UPPER FLOOR
PDP-12	ROOF
PDP-13	ELEVATIONS
PDP-14	ELEVATIONS
PDP-15	ENLARGED ELEVATIONS
PDP-16	SITE SECTIONS

plicable building codes, and notifying Architect mediately of any discrepancies or conflicts.

roughout the Contract Documents. By submitting d for this work the Contractor and all ubcontractors attest that they have reviewed the

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d have included all applicable work. Additional

## HERE KANSAS

OWNER: HERE KANSAS 908 N. HALSTED CHICAGO IL 60607 p. 312 642 0170 jwh@here-llc.com

> 1101 INDIANA ST LAWRENCE, KS

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	DATE	ISSUED FOR
	02/05/14	PDP RESUBMITTAL
	05/06/14	PDP RESUBMITTAL
$\triangle$	06/11/14	PDP RESUBMITTAL
$\triangle$		
$\triangle$		

HARTSHORNE PLUNKARD ARCHITECTURE



PROJ. # 1324 BY: JM DN. BY: KF, NS, JP PROJECT DATA & LOCATION PLAN



